



NOTIFICACIÓN NÚM. 2

**SUBASTA FORMAL 23J-00935
PARA REALIZAR MEJORAS DE CONSTRUCCIÓN PREVENTIVA Y DE
MITIGACIÓN DE DAÑOS FUTUROS EN EL DEPARTAMENTO DE ESTADO DEL
GOBIERNO DE PUERTO RICO**

Asunto: PLANOS ADICIONALES

Se notifica a los licitadores interesados en participar en la subasta de referencia de la siguiente información:

- I. **ENVÍO DE PLANOS ADICIONALES EN FORMATO PDF. (VER ARCHIVO ADJUNTO).**

Esta Notificación forma parte del pliego de Subasta Formal y tendrá que ser considerada junto con su Oferta. Todos los demás términos, condiciones y especificaciones permanecen sin alterar.

Edmarie Avilés Almenas
Secretaria
Junta de Subastas



Emitida hoy, 6 de septiembre de 2022
San Juan, Puerto Rico


INDEX OF DRAWINGS:

GENERAL	
T-1.0	TITLE SHEET
EXISTING CONDITIONS	
D-1.1	EXISTING FIRST LEVEL FLOOR PLAN (FOR REFERENCE ONLY)
D-1.2	EXISTING SECOND LEVEL FLOOR PLAN (FOR REFERENCE ONLY)
D-1.3	EXISTING THIRD LEVEL FLOOR PLAN (FOR REFERENCE ONLY)
D-1.3a	EXISTING FOURTH LEVEL FLOOR PLAN (FOR REFERENCE ONLY)
D-1.4	EXISTING & DEMOLITION ROOF LEVEL PLAN
PROPOSED	
A-1.1	PROPOSED ROOF LEVEL PLAN
A-1.2	STEEL STANDS & AC EQUIPMENT ANCHORAGE DETAILS
A-2.0a	EXISTING WINDOWS & LOCKING HARDWARE & PROPOSED LOCKING HARDWARE
A-2.0b	EXISTING DOORS & LOCKING HARDWARE & PROPOSED LOCKING HARDWARE
A-2.1	EXISTING WINDOWS ELEVATIONS W/ PROPOSED LOCKING HARDWARE
A-2.2	EXISTING WINDOWS ELEVATIONS W/ PROPOSED LOCKING HARDWARE
A-2.3	EXISTING WINDOWS ELEVATIONS W/ PROPOSED LOCKING HARDWARE
A-2.4	EXISTING DOORS ELEVATIONS W/ PROPOSED LOCKING HARDWARE
A-2.5	EXISTING DOORS ELEVATIONS W/ PROPOSED LOCKING HARDWARE
A-2.6	EXISTING DOORS ELEVATIONS W/ PROPOSED LOCKING HARDWARE
A-2.7	EXISTING DOORS ELEVATIONS W/ PROPOSED LOCKING HARDWARE
A-2.8	EXISTING DOORS ELEVATIONS W/ PROPOSED LOCKING HARDWARE
A-2.9	EXISTING DOORS ELEVATIONS W/ PROPOSED LOCKING HARDWARE
A-2.10	WINDOWS & DOORS WEATHERSTRIPS & LOCKING DEVICES DETAILS
A-2.11	WINDOWS & DOORS WEATHERSTRIPS & LOCKING DEVICES DETAILS
A-2.12	WINDOWS & DOORS LOCKING DEVICES DETAILS


LOCATION MAP
NOT TO SCALE



ZONING MAP
NOT TO SCALE

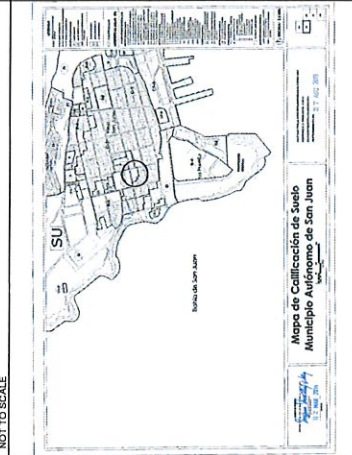

FEMA FLOOD MAP
NOT TO SCALE

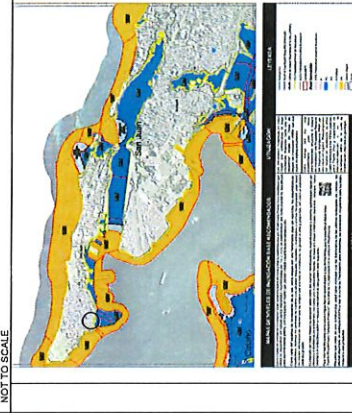

HAZARD MITIGATION FOR STATE DEPARTMENT BUILDING CONSTRUCTION DRAWINGS



CONSTRUCTION FOR
DEPARTMENT FOR STATE
HAZARD MITIGATION BUILDING
SAN JOSE STREET
SAN JUAN, PUERTO RICO



DESIGNED BY	D. LUGO
DRAWN BY	P. J. MARINELLI
CHECKED BY	2023-06-20
DATE	2023
SCALE	AS SHOWN
NO.	
REV.	
DATE	
BY	
CHKD.	
DATE	

PAGE NUMBER
T-1.0

TITLE SHEET




SEAL

DESIGNED BY	D. LUCIO
CHECKED BY	P. J. VIGNETTI
DATE	2/22/2024
PROJECT NO.	21025
SCALE	AS SHOWN
SHEET NO.	1 OF 1
TITLE	

EXISTING & DEMOLITION ROOF LEVEL PLAN

WAGE NUMBER

D-1.4

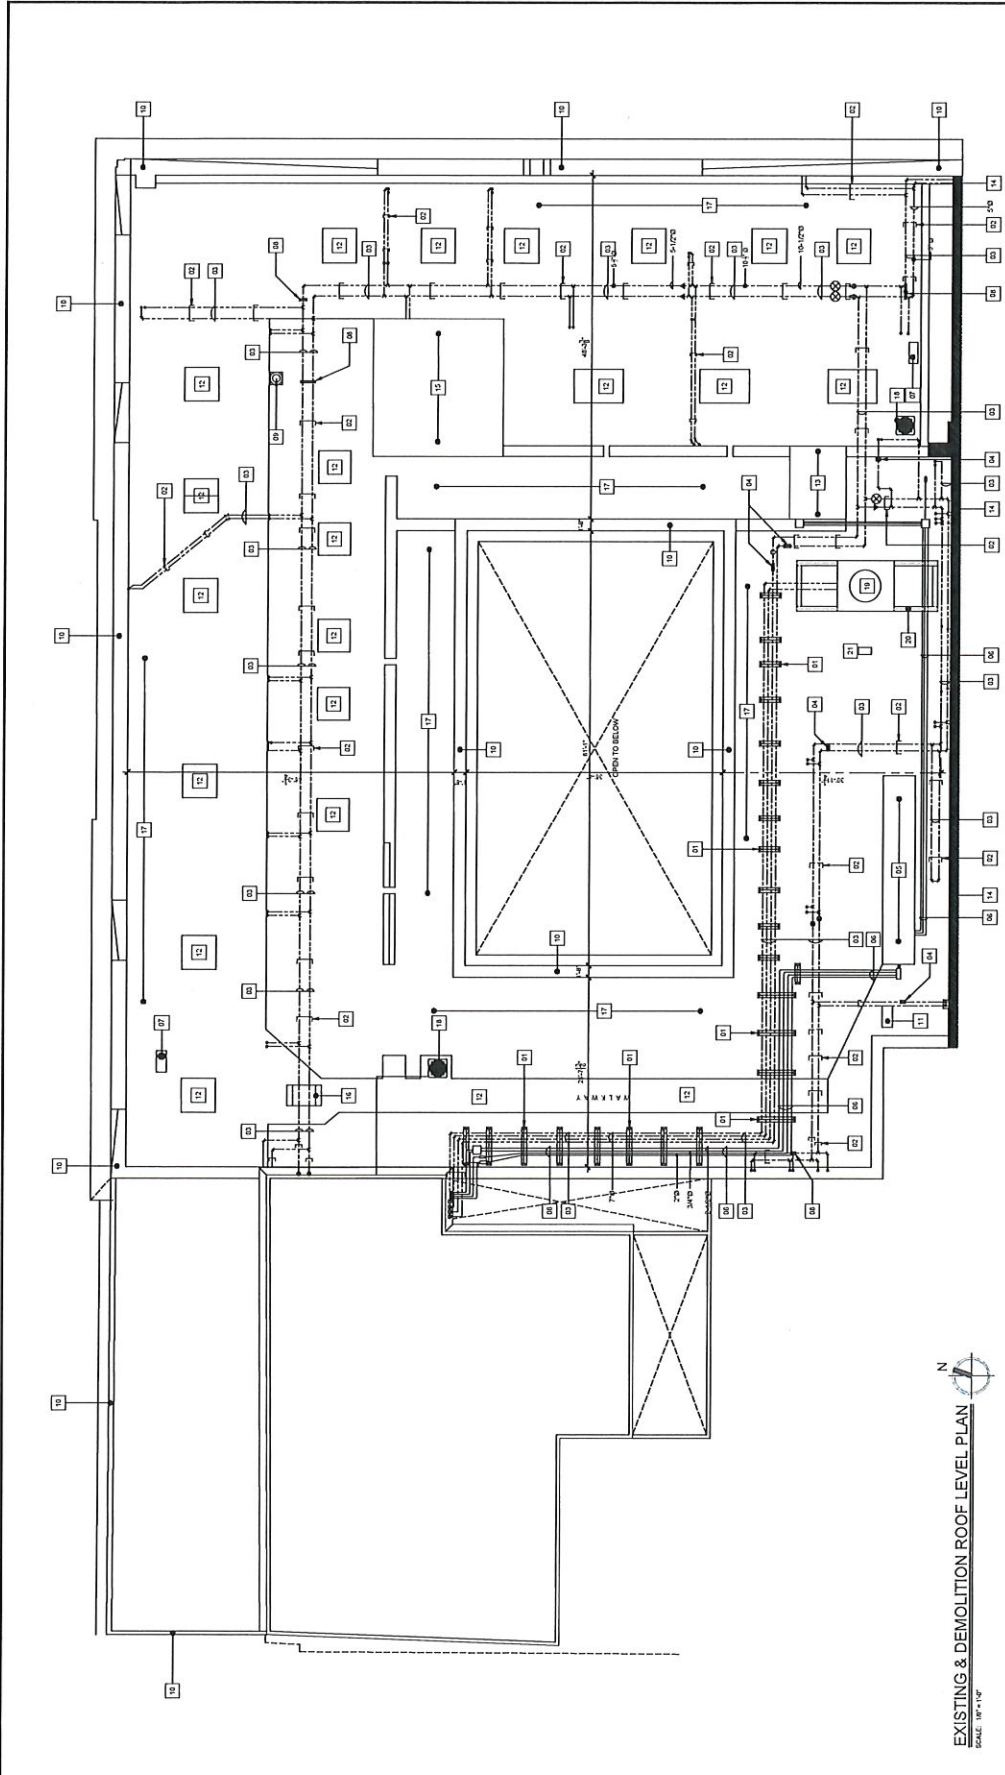

EXISTING & DEMOLITION ROOF LEVEL PLAN
 SCALE: 1/8" = 1'-0"

- EXISTING & DEMOLITION KEY NOTES:**
- EXISTING WELDED STEEL TOP WITH UNSTRUT TO BE REMOVED (TYPICAL)
 - EXISTING HEAVY CORRUGATED STEEL STANGS TO BE REMOVED (TYPICAL)
 - EXISTING CONG. BLOCK TEMPORARY STANGS TO BE REMOVED (TYPICAL)
 - EXISTING CONG. BLOCK TEMPORARY STANGS TO BE REMOVED (TYPICAL)
 - EXISTING ELECTRICAL GUARDRAIL TO REMAIN (TYPICAL)
 - EXISTING ELECTRICAL CONDUITS TO REMAIN (TYPICAL)
 - EXISTING AC EQUIPMENT TO REMAIN
 - EXISTING STEEL TOWER ELECTRICAL PANELS TO BE RELOCATED
 - EXISTING EXHAUST TO REMAIN
 - EXISTING MECHANICAL EQUIPMENT TO REMAIN
 - EXISTING FLOOR PANS TO REMAIN
 - EXISTING MECH. ROOM TO REMAIN
 - EXISTING MECH. ROOM WALL TO REMAIN
 - EXISTING STAIR ROOF TO REMAIN
 - EXISTING STAIRS TO REMAIN
- LEGEND**
- EXISTING HEAVY CORRUGATED STEEL STANGS FOR AC ELECTRICAL PIPES
 - EXISTING TEMPORARY BLOCK STANGS TO BE REMOVED
 - EXISTING TEMPORARY WOOD STANGS TO BE REMOVED
 - EXISTING WELDED STEEL WITH UNSTRUT TO BE REMOVED
 - EXISTING AC PIPES TO REMAIN
 - EXISTING ELECTRICAL CONDUITS TO REMAIN
- IMPORTANT NOTES ABOUT THE ROOF WORK IN THIS PROJECT:**
1. CONTRACTOR SHALL COORDINATE WITH OWNER AND/OR ROOFING CONTRACTOR TO EVALUATE THE EXISTING ROOF PENETRATIONS AND DETERMINE THE NECESSARY REPAIRS TO THE ROOFING WORKS IF ANY.
 2. CONTRACTOR SHALL CONSIDER THE FOLLOWING ITEMS:
 - ANY ASBESTOS AND LEAD REPORT BEFORE REMOVAL OF EXISTING ROOFING MATERIALS.
 - CONTRACTOR SHALL COORDINATE WITH OWNER FOR THE STEEL STANGS AND OR STANGS IN ORDER TO PROPERLY CLEAN, COVER AND REMOVE THEM.
 - THE CONTRACTOR MUST NOT BE SUBJECT TO CLEAN, COVER AND REMOVE EXISTING ROOFING MATERIALS UNDER THE SCOPE OF THE ENTIRE PROJECT.
 - CONTRACTOR MUST OBTAIN ALL NECESSARY PERMITS FOR THE DEMOLITION OF EXISTING ROOFING MATERIALS.
 - CONTRACTOR SHALL NOTIFY ALL NEARBY ADJACENT BUILDINGS AND NEIGHBORING BUILDINGS AND PUBLIC SPACE. ATTENTION MUST BE GIVEN TO ALL NEIGHBORING BUILDINGS AND PUBLIC SPACE. ATTENTION MUST BE GIVEN TO ALL NEIGHBORING BUILDINGS AND PUBLIC SPACE.
 3. CONTRACTOR SHALL VERIFY ALL EXISTING AND REMOVED ROOFING MATERIALS ARE PROPERLY STORED AND THE CONTRACTOR SHALL NOTIFY ALL NEIGHBORING BUILDINGS AND PUBLIC SPACE. ATTENTION MUST BE GIVEN TO ALL NEIGHBORING BUILDINGS AND PUBLIC SPACE.
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**CONSTRUCTION FOR
HAZARD MITIGATION FOR STATE
DEPARTMENT BUILDING
SAN JUAN STREET
ACROSS**



POWER


SCALE

DATE:	D. LUGO
DESIGNED BY:	P. J. MARSHALL
PROJECT NO.:	2022-001
NO.:	2022-001
DATE:	10/20/22
SCALE:	AS SHOWN
SHEET TITLE:	

**PROPOSED ROOF
LEVEL PLAN**

PAGE NUMBER

A-1.1

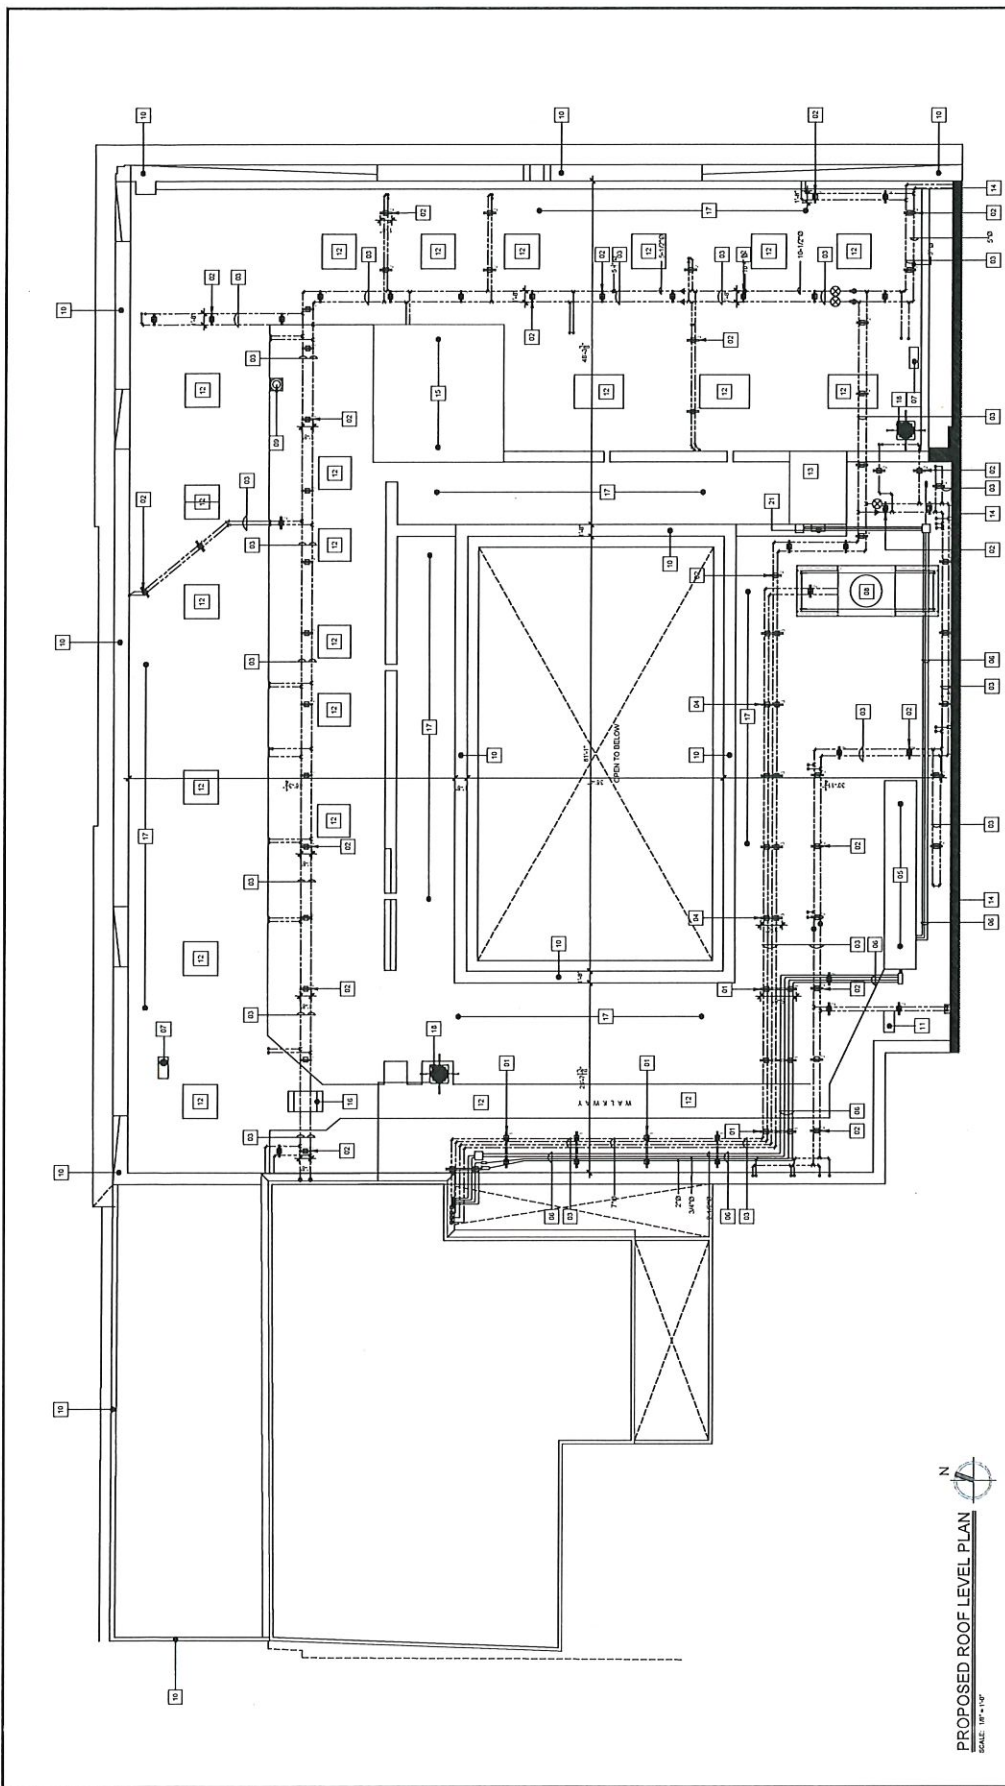

PROPOSED ROOF LEVEL PLAN
SCALE: 1/8" = 1'-0"

PROPOSED ROOF KEY NOTES:

- NEW STEEL SPAND TYPE 'Y' (TYPICAL)
- SEE DETAIL ON SHEET A-1.2
- EXISTING ROOFING MATERIAL TO REMAIN UNLESS OTHERWISE NOTED
- EXISTING AC WATER PIPES TO REMAIN (TYPICAL)
- NEW STEEL SPAND TYPE 'Y' (TYPICAL)
- SEE DETAIL ON SHEET A-1.2
- EXISTING ELECTRICAL CONDUITS TO REMAIN (TYPICAL)
- EXISTING CHLORIDE COATING TOWER TO BE PROPERLY ANCHORED
- EXISTING CONDUIT TO REMAIN
- EXISTING CONDUIT TO REMAIN
- EXISTING ELECTRICAL EQUIPMENT TO REMAIN
- EXISTING LOOP AND TRUNK
- EXISTING CONDUIT TO REMAIN
- EXISTING MAIN ROOF TO REMAIN

LEGEND

- NEW STEEL SPAND TYPE 'Y' FOR AC & ELECTRICAL PIPES
- NEW STEEL SPAND TYPE 'Y' FOR AC & ELECTRICAL PIPES
- EXISTING AC PIPES TO REMAIN
- EXISTING ELECTRICAL CONDUITS TO REMAIN

ADDITIONAL NOTES ABOUT THE ROOF WORK IN THIS PROJECT:

- CONTRACTOR SHALL MAINTAIN THE EXISTING INTEGRITY OF THE ROOFING WORK IN ALL AREAS WHERE THE EXISTING ROOFING IS TO BE MAINTAINED.
- CONTRACTOR SHALL CONSIDER THE FOLLOWING ITEMS:
 - EXISTING ROOF IMPERMEABILIZATION SYSTEM
 - ANY ASBESTOS AND LEAD REPORT BEFORE REMOVAL OF EXISTING ROOF IMPERMEABILIZATION SYSTEM
- CONTRACTOR SHALL COORDINATE WITH WASTE PROVIDER FOR THE STEEL DEBRIS TO BE REMOVED FROM THE PROJECT TO BE PROPERLY HANDLED AND RECYCLED.
- THE CONTRACTOR MUST VERIFY THE PROJECT TO GET FAMILIAR WITH THE EXISTING ROOFING SYSTEM AND THE LOCATION OF ALL EXISTING ROOF WORK TO BE COMPLETED.
- CONTRACTOR MUST CORRECT ALL MEASUREMENTS, ELEVATION LEVELS, OR DIMENSIONS ON THIS DRAWING THAT ARE IN CONFLICT WITH THE AS-BUILT CONDITIONS OF THE PROJECT. THE CONTRACTOR SHALL VERIFY THE ACCURACY OF ALL DIMENSIONS AND ELEVATIONS BEFORE THE START OF WORK. THE CONTRACTOR SHALL BE RESPONSIBLE FOR THE CORRECTION OF ANY DISCREPANCIES. THE CONTRACTOR SHALL BE RESPONSIBLE FOR THE CORRECTION OF ANY DISCREPANCIES. THE CONTRACTOR SHALL BE RESPONSIBLE FOR THE CORRECTION OF ANY DISCREPANCIES.



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**CONSTRUCTION FOR
HAZARD MITIGATION FOR STATE
DEPARTMENT BUILDING**
SAN JOSE STREET
SAN JUAN, PUERTO RICO



OWNER





DESIGNED BY	D. LUGO
CHECKED BY	D. J. AGOSTINI
PROJECT NO.	21-200
DATE	
NO.	
REVISION	

SHEET TITLE
**STEEL STANDS & A/C
EQUIPMENT ANCHORAGE
DETAILS**





PAGE NUMBER
A-1.2

IMPORTANT NOTES ABOUT THE ROOF WORKS IN THIS PROJECT:





1. CONTRACTOR SHALL VERIFY THE EXISTING ROOF IMPERMEABILIZATION SYSTEM FOR ANY DEFECTS AND REPORT TO THE ARCHITECT IMMEDIATELY UPON DISCOVERY. CONTRACTOR SHALL MAINTAIN THE EXISTING ROOF IMPERMEABILIZATION WORKS IF ANY.
2. CONTRACTOR SHALL CONSIDER THE FOLLOWING ITEMS:
- ANY ASBESTOS AND LEAD REPORT BEFORE REMOVAL OF EXISTING ROOF IMPERMEABILIZATION SYSTEM.
3. CONTRACTOR SHALL COORDINATE WITH PAINT PROVIDER FOR THE STEEL STANDS AND EQUIPMENT ANCHORAGE. CONTRACTOR SHALL PROTECT THE STEEL CLAMPS OF CORROSION. THE CONTRACTOR MUST NOT USE THE PRODUCT TO GET ALUMINUM WITH THE STEEL STANDS AND EQUIPMENT ANCHORAGE. THE CONTRACTOR SHALL VERIFY THE ROOF WORKS TO BE COMPLETED.

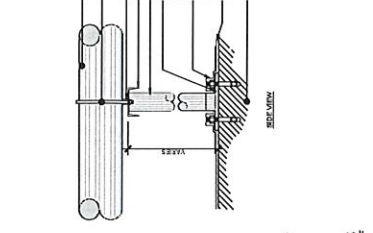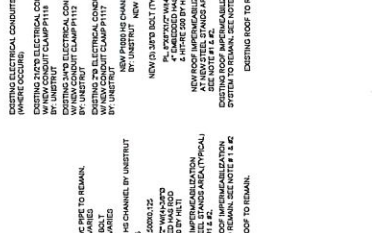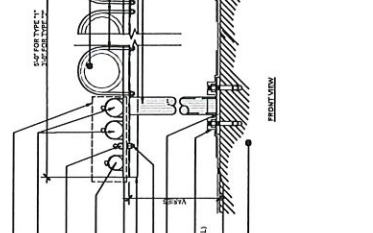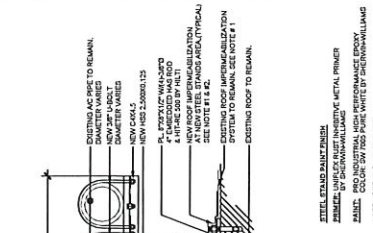

STEEL STAND TYPE "1" & "3" DETAILS
SCALE: 1/8"=1'-0"

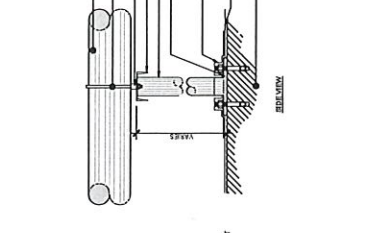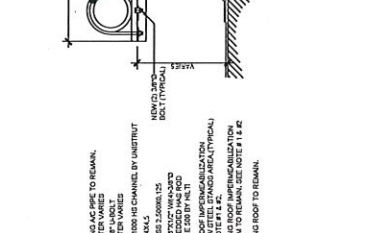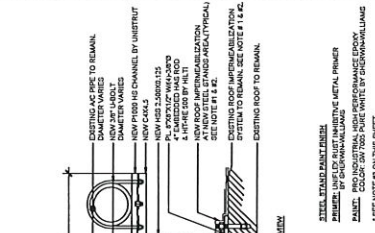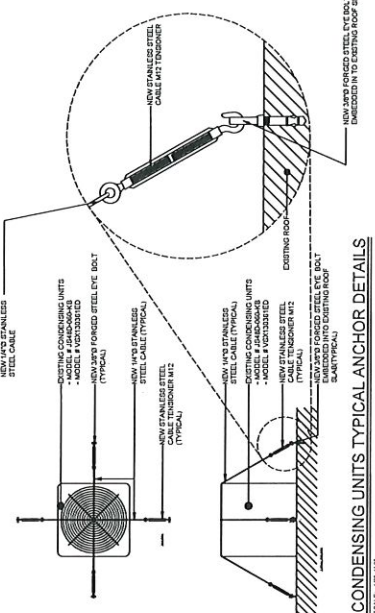

STEEL STAND TYPE "2" DETAILS
SCALE: 1/8"=1'-0"

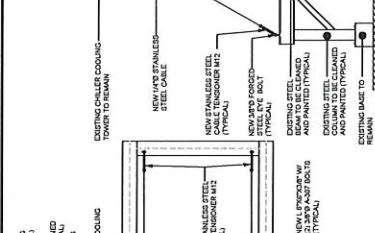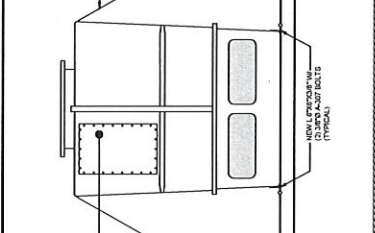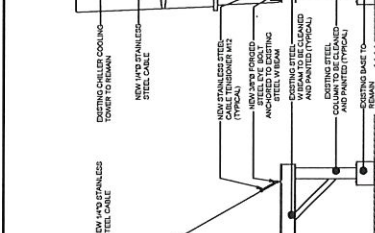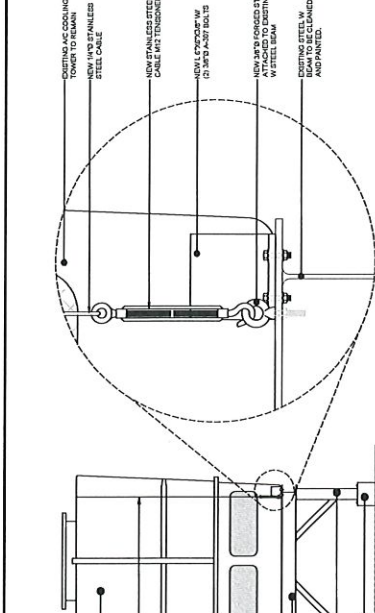

COOLING TOWER ANCHOR DETAILS
SCALE: 3/8"=1'-0"



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**CONSTRUCTION FOR
HAZARD MITIGATION FOR STATE
DEPARTMENT BUILDING**

PROJECT
SAN JOSE STREET
SAN JUAN, PUERTO RICO



SEAL

DESIGNED BY	D. LUD
CHECKED BY	D. LUD
DATE	20-07-20
PROJECT NO.	20-07-20
SCALE	AS SHOWN
SHEET TITLE	

**EXISTING WINDOWS
ELEVATIONS W/ PROPOSED
LOCKING HARDWARE**
PAGE NUMBER




A-2.1

WINDOWS KEY NOTES:

- 1. EXISTING TOP WINDOW WOOD FRAME TO REMAIN.
- 2. EXISTING WINDOW WOOD FRAME TO REMAIN.
- 3. EXISTING TOP VERTICAL EXTENDED GLASS SURFACE LOCKING DEVICE TO REMAIN (TYPICAL).
- 4. EXISTING WINDOW WOOD JOIST TO REMAIN.
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IMPORTANT NOTES ABOUT WINDOWS IN THIS PROJECT

1. ALL WINDOWS INCLUDING EXISTING AND PROPOSED SHALL BE REFERENCED TO THE WINDOW SCHEDULE AND THE WINDOW SCHEDULE SHALL BE USED TO DETERMINE THE PROPOSED WINDOW TYPE AND THE PROPOSED WINDOW TYPE SHALL BE USED TO DETERMINE THE WINDOW TYPE AND THE WINDOW TYPE SHALL BE USED TO DETERMINE THE WINDOW TYPE.
2. WINDOWS SHALL BE REFERENCED TO THE WINDOW SCHEDULE AND THE WINDOW SCHEDULE SHALL BE USED TO DETERMINE THE WINDOW TYPE AND THE WINDOW TYPE SHALL BE USED TO DETERMINE THE WINDOW TYPE.
3. WINDOWS SHALL BE REFERENCED TO THE WINDOW SCHEDULE AND THE WINDOW SCHEDULE SHALL BE USED TO DETERMINE THE WINDOW TYPE AND THE WINDOW TYPE SHALL BE USED TO DETERMINE THE WINDOW TYPE.
4. PART OF WINDOWS THAT HAVE TO BE PAINTED IF NEEDED WILL BE SELECTED BY ARCHITECT/OWNER.
5. FOR LOCKING DEVICE QUANTITIES OF EACH WINDOW REFER TO SHEET PA-2.0A.



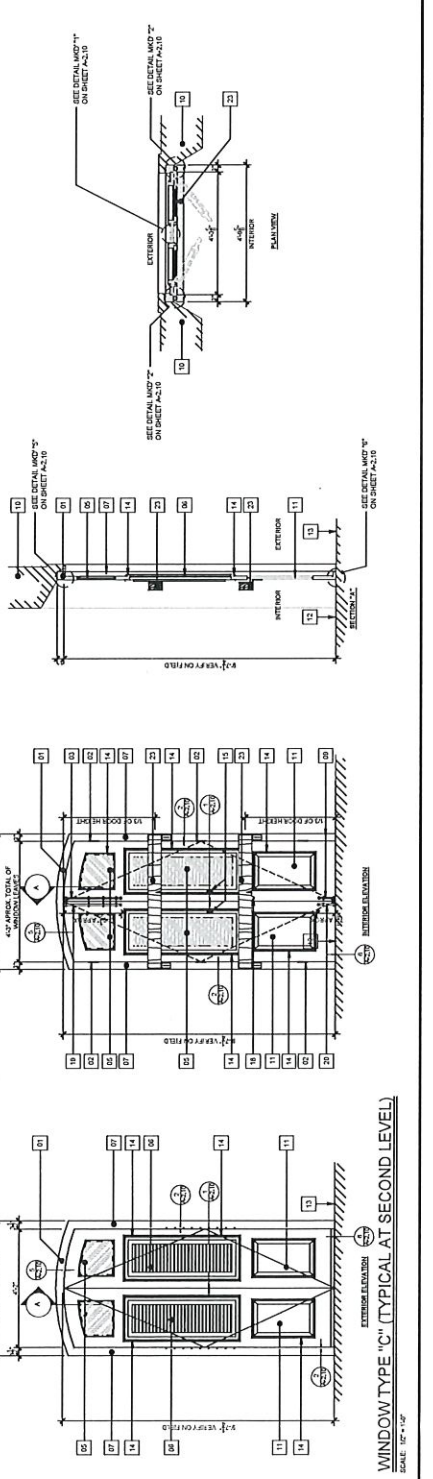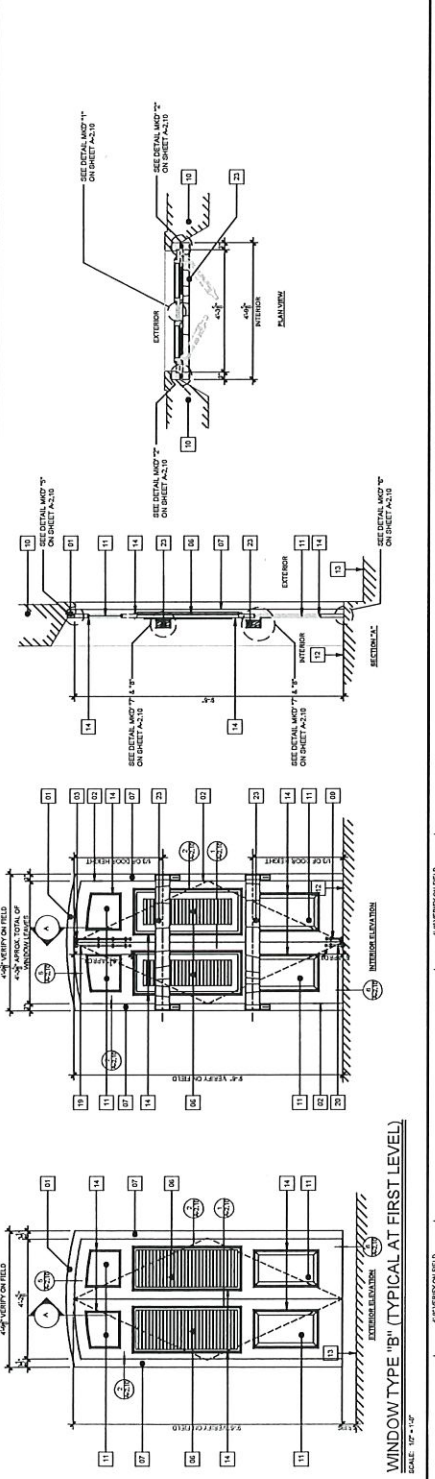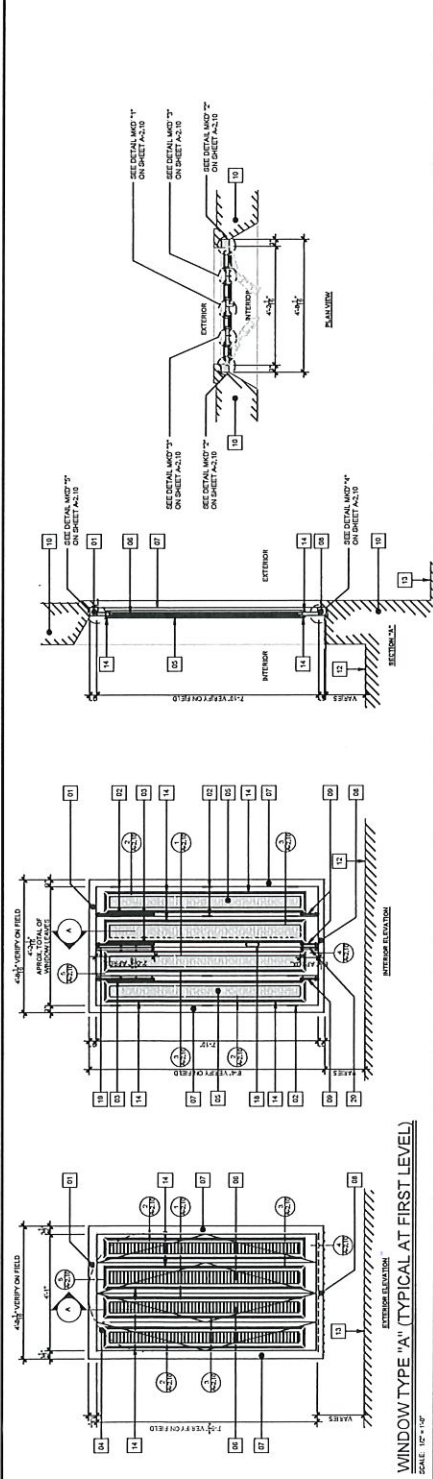

SCALE

DESIGNED BY	D. LUGO
CHECKED BY	P. J. MACIETTI
DATE	02/20/20
PROJECT NO.	200-200
NO.	
DATE	
SHEET TITLE	

EXISTING WINDOWS
 ELEVATIONS W/ PROPOSED
 LOCKING HARDWARE
 PAGE NUMBER




A-2.3

WINDOWS KEY NOTES:

1. EXISTING TOP WINDOW WOOD FRAME TO REMAIN.
2. EXISTING WINDOW WOOD FRAME TO REMAIN.
3. EXISTING TOP VENTAGE SLITS LOCK ZABRACE LOCKING DEVICE TO REMAIN (TYPICAL).
4. EXISTING WINDOW WOOD FRAME TO REMAIN.
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100. EXISTING WINDOW WOOD FRAME TO REMAIN.

IMPORTANT NOTES ABOUT WINDOWS IN THIS PROJECT

1. ALL WINDOWS IN THIS PROJECT SHALL BE REPAIRED OR REPLACED AS NECESSARY. THE CONTRACTOR SHALL VERIFY EACH WINDOW'S CONDITION AND MAKE REPAIRS OR REPLACEMENTS AS NECESSARY TO CORRECT THE PROPOSED INSTALLATION OF THE PROPOSED LOCKING HARDWARE AND WEATHERSTRIP COMPONENT.
2. THE CONTRACTOR SHALL VERIFY THE CONDITION OF EACH LOCKING HARDWARE AND WEATHERSTRIP COMPONENT. IF ANY LOCKING HARDWARE AND WEATHERSTRIP COMPONENT IS FOUND TO BE DEFECTIVE, THE CONTRACTOR SHALL REPAIR OR REPLACE THE DEFECTIVE COMPONENT.
3. WINDOWS SHALL BE REPAIRED AND FINISHED IN ORDER TO MEET THE REQUIREMENTS OF THE PROPOSED INSTALLATION. THE CONTRACTOR SHALL VERIFY THE CONDITION OF EACH WINDOW AND MAKE REPAIRS OR REPLACEMENTS AS NECESSARY TO CORRECT THE PROPOSED INSTALLATION OF LOCKING HARDWARE AND WEATHERSTRIP COMPONENT.
4. PAINT OF WINDOWS THAT HAVE TO BE PAINTED IF NEEDED WILL BE SELECTED BY ARCHITECT / ENGINEER.
5. THE CONTRACTOR SHALL VERIFY THE CONDITION OF EACH WINDOW AND MAKE REPAIRS OR REPLACEMENTS AS NECESSARY TO CORRECT THE PROPOSED INSTALLATION OF LOCKING HARDWARE AND WEATHERSTRIP COMPONENT.
6. FOR LOCKING DEVICES QUANTITIES OF EACH WINDOW REFERS TO SHEET A-2.3A.

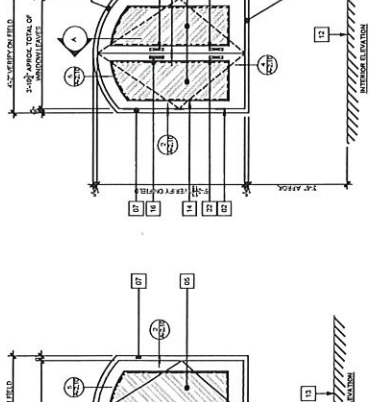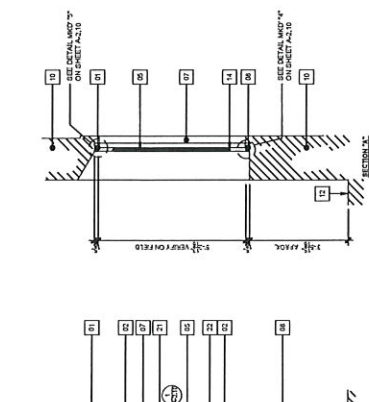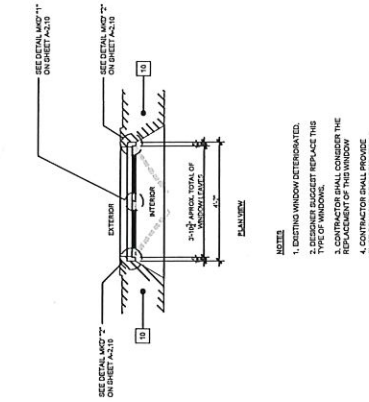

WINDOW TYPE 'G' (TYPICAL AT THIRD LEVEL)
 SCALE: 3/4" = 1'-0"



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**CONSTRUCTION FOR
HAZARD MITIGATION FOR STATE
DEPARTMENT BUILDING**

PROJECT
**CONSTRUCTION FOR
HAZARD MITIGATION FOR STATE
DEPARTMENT BUILDING**
ADDRESS
**SAN JOSE STREET
SAN JUAN, PUERTO RICO**



SCALE

DESIGNED BY	D. LUCIO
CHECKED BY	P. J. VADUETTI
DATE	03/20/20
PROJECT NO.	200-200
DATE	
SCALE	
SHEET TITLE	

EXISTING DOORS
ELEVATIONS W/ PROPOSED
LOCKING HARDWARE


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A-2.8

DOORS KEY NOTES:


1. EXISTING TOP DOOR WOOD FRAME TO REMAIN.
2. EXISTING DOOR WOOD PANELS TO REMAIN TYPICAL.
3. EXISTING TOP WOOD WEDGE BRACKS BRASS FINISH LOCKING DEVICE TO REMAIN TYPICAL.
4. EXISTING MASONRY ARCH AT EXTERIOR.
5. EXISTING FIBER GLASS TO REMAIN.
6. EXISTING WINDOW WOOD JOIST TO REMAIN.
7. EXISTING SIDE DOOR WOOD FRAME TO REMAIN.
8. EXISTING BOTTOM WINDOW FRAME TO REMAIN.
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100. EXISTING WINDOW WOOD JOIST TO REMAIN.

IMPORTANT NOTES ABOUT DOORS IN THIS PROJECT


1. ALL DOOR DIMENSIONS IN ELEVATIONS AND SECTIONS ARE FOR EXISTING DOORS UNLESS OTHERWISE NOTED. DIMENSIONS FOR PROPOSED DOORS ARE FOR THE DOOR FRAME AND DOOR LEAF IN ORDER TO INCLUDE MORTISES, FRAMES AND DOOR LEAVES IN ORDER TO PROVIDE PROPER OPERATOR OF THE MACHINERY MATERIAL AND HARDWARE AND WOOD TRIM COMPONENTS.
2. CONTRACTOR SHALL SUPPLY CRIP DRAWINGS FOR THE COMPONENTS.
3. DOORS SHALL BE REPAIRED IF NEEDED AND FINISHED IN ORDER TO MATCH EXISTING DOORS. CONTRACTOR SHALL PROVIDE MATERIAL AND HARDWARE TO MATCH EXISTING DOORS.
4. PAINT OF DOORS THAT HAVE TO BE PAINTED IF NEEDED WILL BE SELECTED BY ARCHITECT/OWNER.
5. CONTRACTOR SHALL PROVIDE LABEL DOOR AND WINDOW DETAIL ON SHEETS A-2.9 TO A-2.11.
6. FOR LOCKING DEVICES QUANTITIES OF EACH DOOR REFER TO SHEET A-2.9.

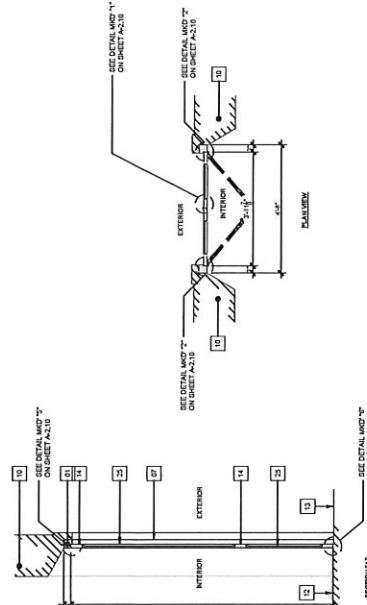

DOOR TYPE "9" (TYPICAL AT SECOND LEVEL BATHROOMS-9i & 9u)
SCALE: 1/8" = 1'-0"

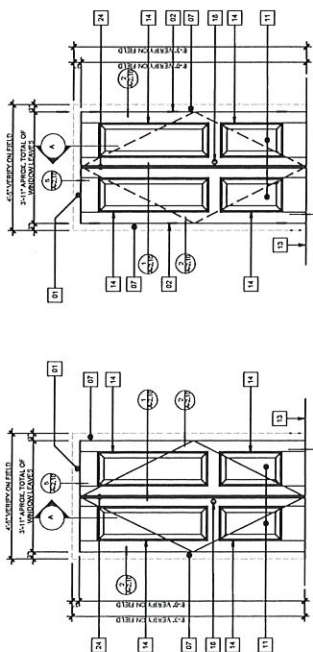

DOOR TYPE "10" (TYPICAL AT THIRD LEVEL-10i & 10u)
SCALE: 1/8" = 1'-0"

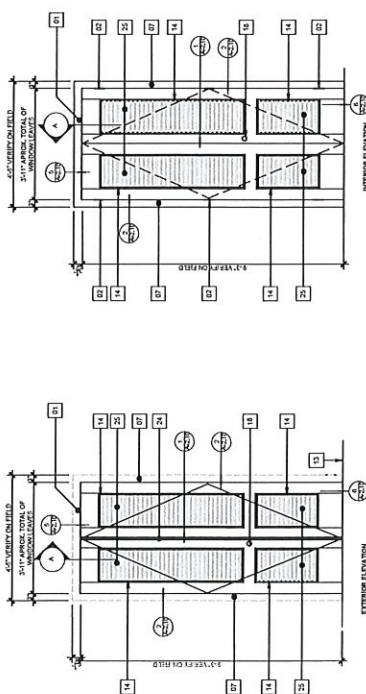

DOOR TYPE "10" (TYPICAL AT THIRD LEVEL BATHROOMS-10i & 10u)
SCALE: 1/8" = 1'-0"



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ADVANTAGE, PSC
P.O. BOX 6025
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CONSTRUCTION FOR
HAZARD MITIGATION FOR STATE
DEPARTMENT BUILDING
SAN JOSE STREET
SAN JUAN, PUERTO RICO
00905



SCALE

DESIGNED BY	D. LUCIO	DATE	
DRAWN BY	P. J. VASQUEZ	DATE	
CHECKED BY		DATE	
APPROVED BY		DATE	
SCALE			

EXISTING DOORS
ELEVATIONS W/ PROPOSED
LOCKING HARDWARE

PAGE NUMBER


A-2.9

DOORS KEY NOTES:


1. EXISTING TOP DOOR WOOD FRAME TO REMAIN.
2. EXISTING DOOR FINISHES TO REMAIN (TYPICAL).
3. EXISTING DOOR LOCKING DEVICE TO REMAIN (TYPICAL).
4. EXISTING MASONRY ARCH AT EXTERIOR.
5. EXISTING FIBER GLASS TO REMAIN.
6. EXISTING WINDWOOD GLASS TO REMAIN.
7. EXISTING SIDE DOOR WOOD FRAME TO REMAIN.
8. EXISTING BOTTOM WINDWOOD FRAME TO REMAIN.
9. EXISTING WINDWOOD GLASS TO REMAIN (TYPICAL).
10. EXISTING LOCKING DEVICE TO REMAIN (TYPICAL).
11. EXISTING MASONRY WALL TO REMAIN.
12. EXISTING WOOD FIBER TO REMAIN.
13. EXISTING INTERIOR FLOOR FINISH TO REMAIN.
14. EXISTING EXTERIOR FLOOR FINISH TO REMAIN.
15. EXISTING DOOR WELDING OPERATOR TO REMAIN (TYPICAL).
16. EXISTING WOOD ALDSUSE OPERATOR TO REMAIN (TYPICAL).
17. EXISTING LOCKING DEVICE TO REMAIN.
18. EXISTING BOTTOM WOOD DOOR MANUAL FLUSHOUT VERTICAL LOCKING DEVICE TO REMAIN.
19. EXISTING DOOR HANDLE TO REMAIN.
20. EXISTING DOOR FINISH TO REMAIN.
21. NEW BOTTOM WINDWOOD DOOR SURFACE TO REMAIN (TYPICAL).
22. NEW TOP WOOD DOOR MANUAL FLUSHOUT VERTICAL LOCKING DEVICE TO REMAIN.
23. NEW WINDWOOD HORIZONTAL LOCKING DEVICE (BARRICADE TYPE).
24. EXISTING ACTUAL TO REMAIN.
25. EXISTING TOP DOOR METAL FRAME.
26. EXISTING SIDE DOOR METAL FRAME.
27. NEW HORIZONTAL SURFACE LOCKING DEVICE.
28. NEW WINDWOOD HORIZONTAL LOCKING DEVICE (BARRICADE TYPE).
29. NEW WINDWOOD HORIZONTAL LOCKING DEVICE (BARRICADE TYPE).
30. EXISTING ACTUAL TO REMAIN.
31. EXISTING TOP DOOR METAL FRAME.
32. EXISTING SIDE DOOR METAL FRAME.
33. NEW HORIZONTAL SURFACE LOCKING DEVICE.
34. NEW WINDWOOD HORIZONTAL LOCKING DEVICE (BARRICADE TYPE).
35. NEW WINDWOOD HORIZONTAL LOCKING DEVICE (BARRICADE TYPE).

IMPORTANT NOTES ABOUT DOORS IN THIS PROJECT:

1. ALL DOOR DIMENSIONS IN ELEVATIONS AND SECTIONS ARE FOR UNFINISHED DOORS. CONTRACTOR SHALL VERIFY ALL DIMENSIONS INCLUDING MASONRY, FRAMES AND DOOR LEAVES IN ORDER TO CORRECTLY ORDER AND INSTALL THE PROPOSED LOCKING HARDWARE AND WINDWOOD STRIP COMPONENTS.
2. CONTRACTOR SHALL SUPPLY SHOP DRAWINGS FOR THE COMPONENTS.
3. DOORS SHALL BE REPAIRED IF NEEDED AND FINISHED IN ORDER TO MATCH EXISTING DOORS. CONTRACTOR SHALL VERIFY ALL DIMENSIONS INCLUDING MASONRY, FRAMES AND DOOR LEAVES IN ORDER TO CORRECTLY ORDER AND INSTALL THE PROPOSED LOCKING HARDWARE AND WINDWOOD STRIP COMPONENTS.
4. PAINT OF DOORS THAT HAVE TO BE PAINTED IF NEEDED WILL BE SELECTED BY ARCHITECT/ENGINEER.
5. CONTRACTOR SHALL VERIFY ALL DIMENSIONS INCLUDING MASONRY, FRAMES AND DOOR LEAVES IN ORDER TO CORRECTLY ORDER AND INSTALL THE PROPOSED LOCKING HARDWARE AND WINDWOOD STRIP COMPONENTS.
6. FOR LOCKING DEVICES QUANTITIES OF EACH DOOR REFER TO SHEET P-2.9.

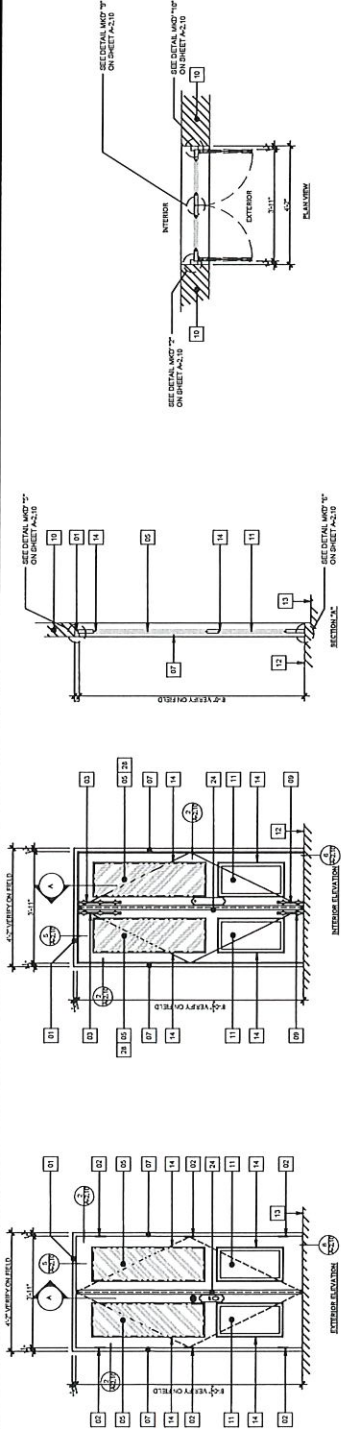

DOOR TYPE "11" (TYPICAL AT FOURTH LEVEL)
SCALE: 1/8" = 1'-0"

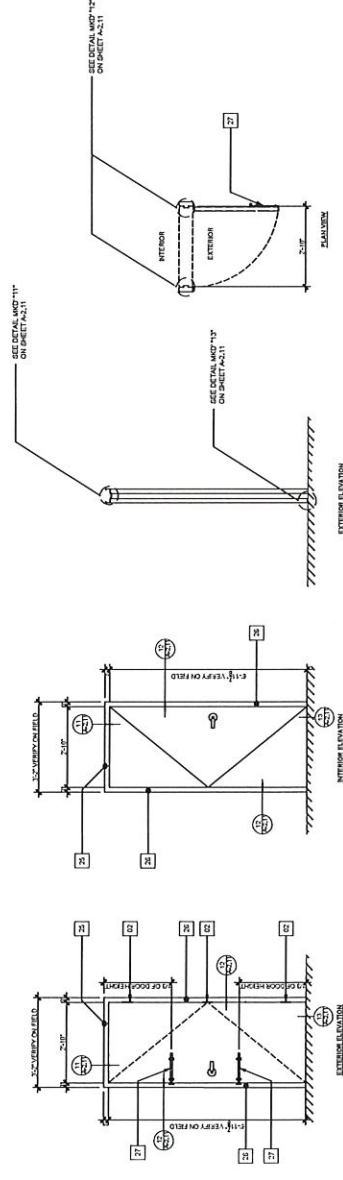

DOOR TYPE "12" (TYPICAL AT ROOF LEVEL)
SCALE: 1/8" = 1'-0"



SEAL

DESIGNED BY	D. LLOCO
CHECKED BY	D. J. VASQUEZ
DATE	2023-09-09
PROJECT NO.	2023-0000
DATE	2023
SCALE	
NO.	
DATE	
BY	
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BY	
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SHEET TITLE:
**WINDOWS & DOORS
LOCKING DEVICES
DETAILS**

PAGE NUMBER

A-2.12

**IMPORTANT NOTES ABOUT WINDOWS & DOORS
DETAILS IN THIS PROJECT.**

1. ALL DOORS & WINDOWS ELEVATIONS AND SECTIONS ARE FOR INFORMATION ONLY. CONTRACTOR SHALL VERIFY ALL DIMENSIONS INCLUDING MOLDINGS, FRAMES AND DOOR LEAVES IN ORDER TO DETERMINE THE EXISTING CONDITIONS. THE PROPOSED LOCKING HARDWARE AND WEATHERSTRIP COMPONENTS.
2. CONTRACTOR SHALL VERIFY SHOP DRAWINGS FOR THE COMPONENTS.
3. DOORS AND WINDOWS SHALL BE REPAIRED AND OR ALIGNED IF NECESSARY TO ACCOMMODATE THE PROPOSED LOCKING HARDWARE AND WEATHERSTRIP COMPONENTS. CONTRACTOR SHALL VERIFY EACH DOOR AND WINDOW TO BE REPAIRED AND OR ALIGNED TO BE PROPERLY INSTALLED. CONTRACTOR SHALL VERIFY EACH DOOR AND WINDOW TO BE REPAIRED AND OR ALIGNED TO BE PROPERLY INSTALLED. CONTRACTOR SHALL VERIFY EACH DOOR AND WINDOW TO BE REPAIRED AND OR ALIGNED TO BE PROPERLY INSTALLED. CONTRACTOR SHALL VERIFY EACH DOOR AND WINDOW TO BE REPAIRED AND OR ALIGNED TO BE PROPERLY INSTALLED.
4. PAINT OF DOORS AND WINDOWS THAT HAVE TO BE PAINTED IF NECESSARY SHALL BE MATCHED TO THE EXISTING PAINT. CONTRACTOR SHALL VERIFY EACH DOOR AND WINDOW TO BE REPAIRED AND OR ALIGNED TO BE PROPERLY INSTALLED. CONTRACTOR SHALL VERIFY EACH DOOR AND WINDOW TO BE REPAIRED AND OR ALIGNED TO BE PROPERLY INSTALLED.
5. CONTRACTOR SHALL VERIFY EACH DOOR AND WINDOW TO BE REPAIRED AND OR ALIGNED TO BE PROPERLY INSTALLED. CONTRACTOR SHALL VERIFY EACH DOOR AND WINDOW TO BE REPAIRED AND OR ALIGNED TO BE PROPERLY INSTALLED.
6. CONTRACTOR SHALL VERIFY EACH DOOR AND WINDOW TO BE REPAIRED AND OR ALIGNED TO BE PROPERLY INSTALLED. CONTRACTOR SHALL VERIFY EACH DOOR AND WINDOW TO BE REPAIRED AND OR ALIGNED TO BE PROPERLY INSTALLED.
7. CONTRACTOR SHALL VERIFY EACH DOOR AND WINDOW TO BE REPAIRED AND OR ALIGNED TO BE PROPERLY INSTALLED. CONTRACTOR SHALL VERIFY EACH DOOR AND WINDOW TO BE REPAIRED AND OR ALIGNED TO BE PROPERLY INSTALLED.
8. CONTRACTOR SHALL VERIFY EACH DOOR AND WINDOW TO BE REPAIRED AND OR ALIGNED TO BE PROPERLY INSTALLED. CONTRACTOR SHALL VERIFY EACH DOOR AND WINDOW TO BE REPAIRED AND OR ALIGNED TO BE PROPERLY INSTALLED.
9. CONTRACTOR SHALL VERIFY EACH DOOR AND WINDOW TO BE REPAIRED AND OR ALIGNED TO BE PROPERLY INSTALLED. CONTRACTOR SHALL VERIFY EACH DOOR AND WINDOW TO BE REPAIRED AND OR ALIGNED TO BE PROPERLY INSTALLED.
10. CONTRACTOR SHALL VERIFY EACH DOOR AND WINDOW TO BE REPAIRED AND OR ALIGNED TO BE PROPERLY INSTALLED. CONTRACTOR SHALL VERIFY EACH DOOR AND WINDOW TO BE REPAIRED AND OR ALIGNED TO BE PROPERLY INSTALLED.
11. FOR LOCKING DEVICES QUANTITIES OF EACH DOOR & WINDOW REFER TO SHEET P-10.1.1.

