




PROJECT NAME

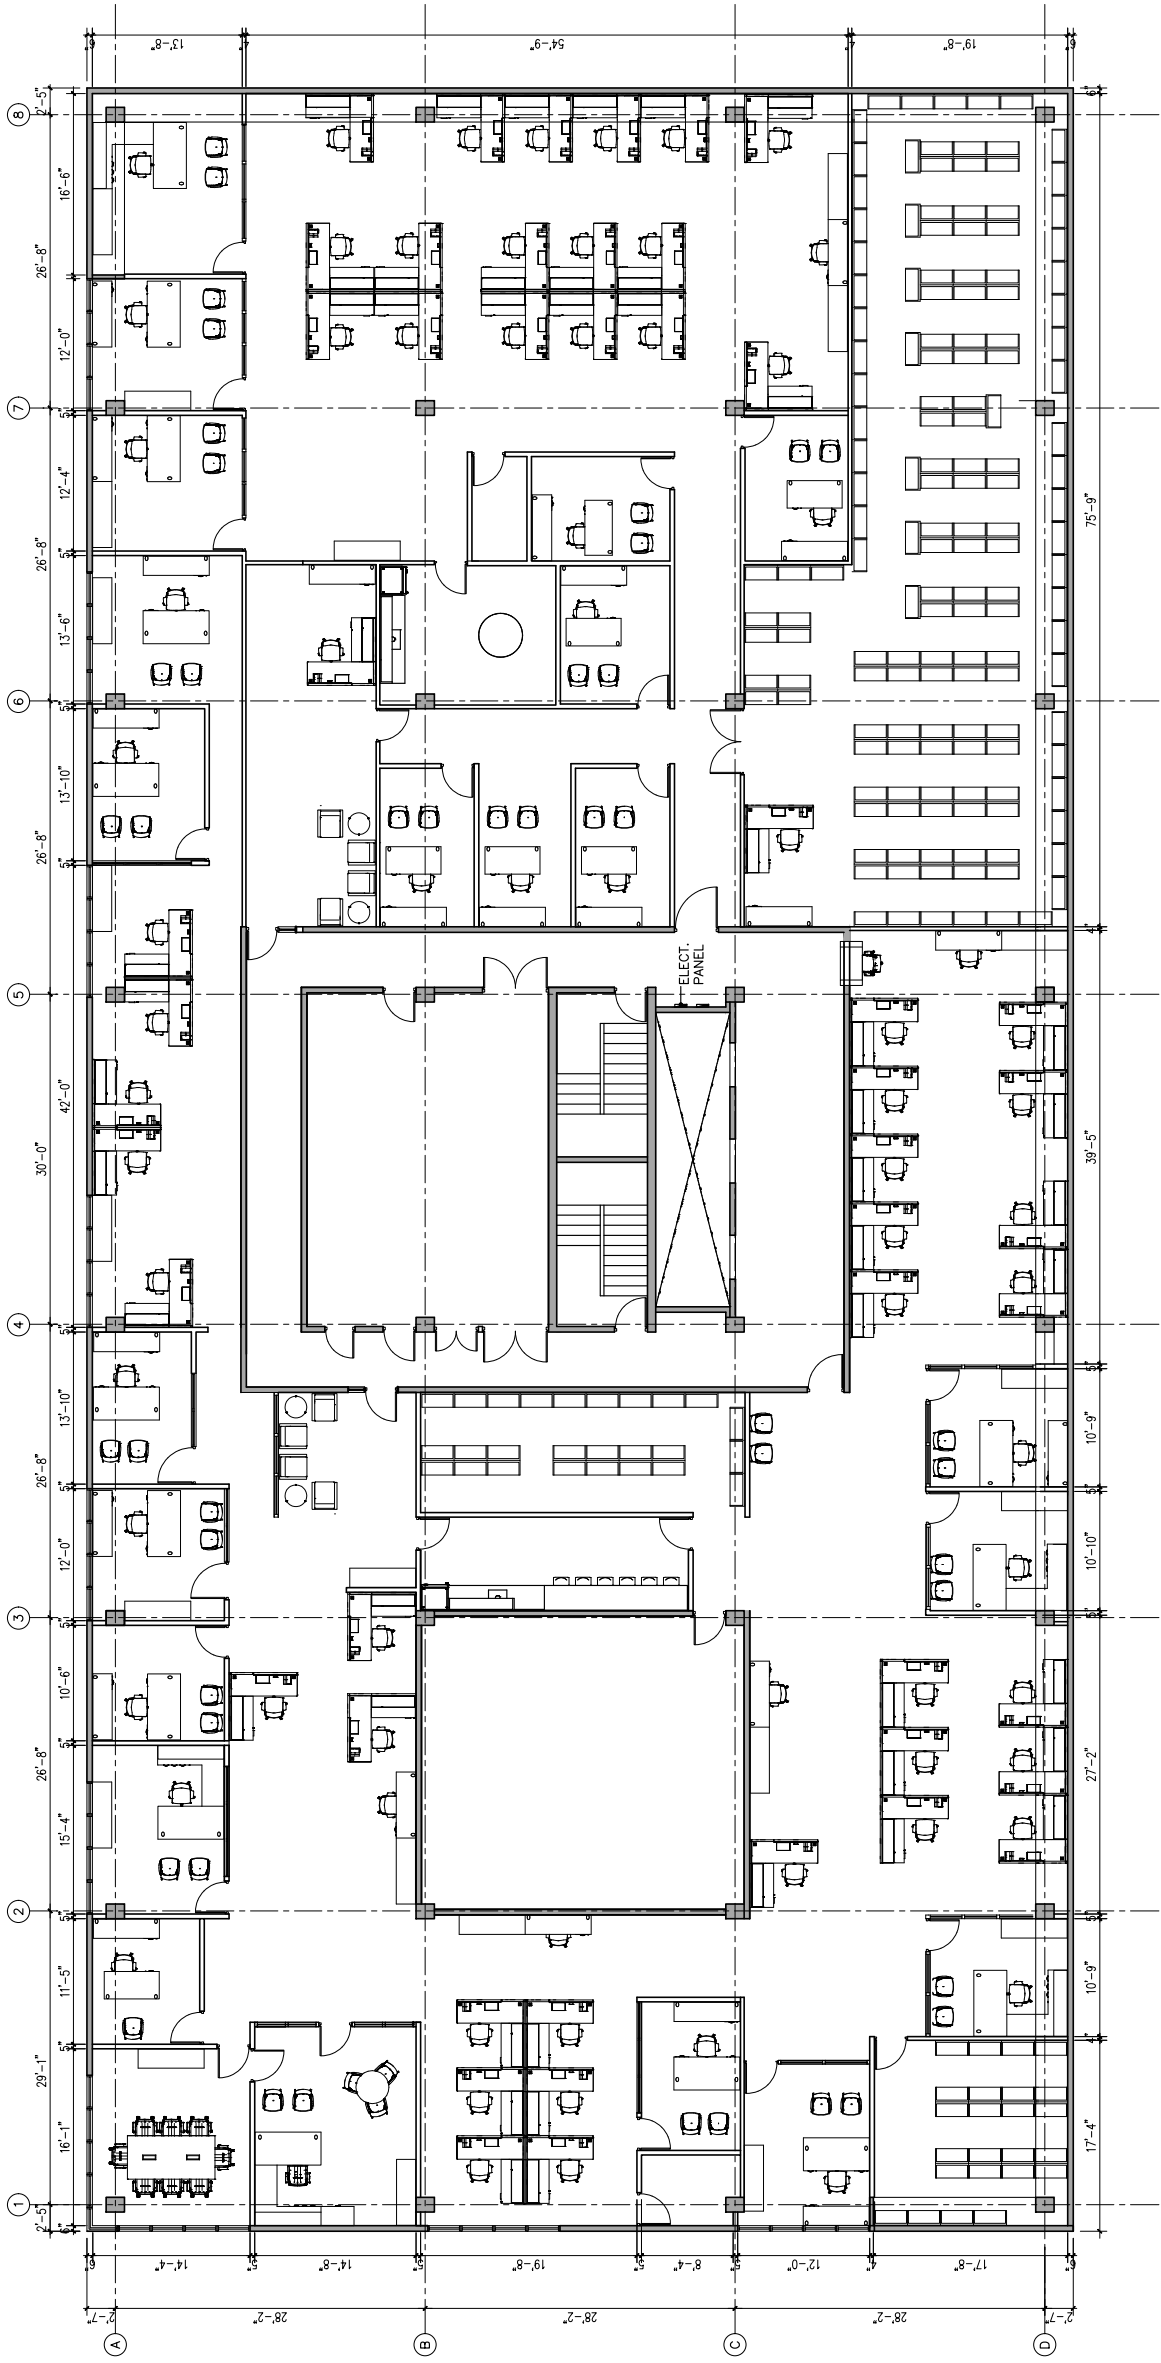

8TH FLOOR FURNITURE PLAN

SCALE: 1/8" = 1'-0"

REVISIONS	
NO.	DESCRIPTION

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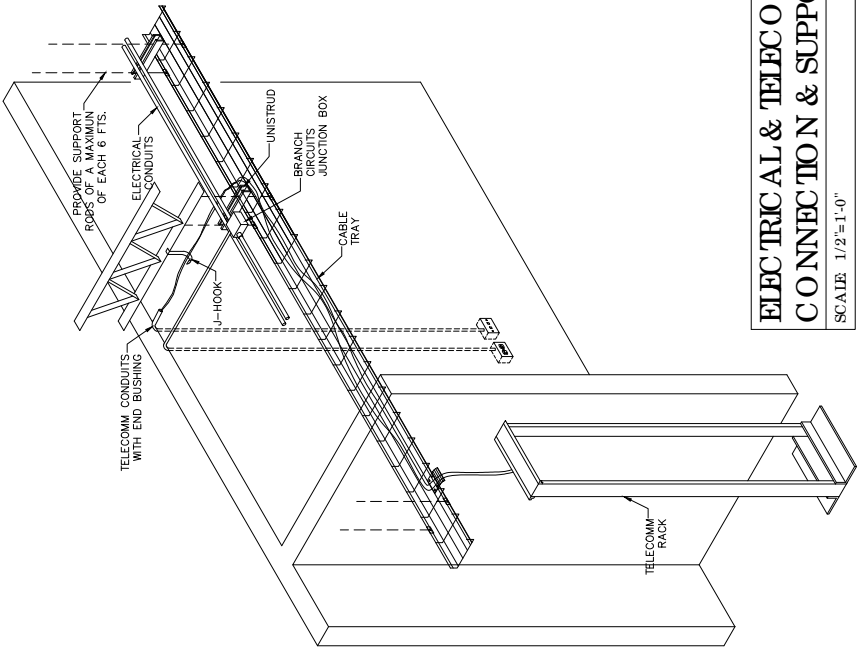
DRAWN BY: _____
CHECKED BY: _____
DATE: _____

DRAWING TITLE
8TH FLOOR FURNITURE PLAN


SCALE: 1/8" = 1'-0"	DRAWING NO. A-3.0
PROJECT NO.	SHEET NO.
DATE	




YO, HERNÁN R. HERNÁNDEZ, ARQUITECTO LICENCIADO, NUMERO DE LICENCIATURA 1000, CERTIFICO QUE SOY EL PROFESIONAL QUE DISEÑO ESTOS PLANOS Y QUE HE REVISADO LOS PLANOS Y ESPECIFICACIONES DE ACUERDO CON LAS REGLAS DE LA ASOCIACION PUERTORRUECA DE ARQUITECTOS Y CON LAS DISPOSICIONES DE LA LEY DE LOS SERVIDORES PUBLICOS DE LA ASOCIACION. ANTES DE EMITIR ESTOS PLANOS HE VERIFICADO QUE LAS DIMENSIONES Y LOS MATERIALES DE LOS ELEMENTOS DE LA OBRA SE ADECUAN A LA ESPECIFICACION DE LOS MATERIALES QUE SE HA PRODUCCION EN EL PAIS. ESTOS PLANOS SON UN PRODUCTO DE MI OFICINA DE ARQUITECTURA Y NO SON UN PRODUCTO DE NINGUN OTRO PROFESIONAL. YO, HERNÁN R. HERNÁNDEZ, ARQUITECTO LICENCIADO, NUMERO DE LICENCIATURA 1000, CERTIFICO QUE SOY EL PROFESIONAL QUE DISEÑO ESTOS PLANOS Y QUE HE REVISADO LOS PLANOS Y ESPECIFICACIONES DE ACUERDO CON LAS REGLAS DE LA ASOCIACION PUERTORRUECA DE ARQUITECTOS Y CON LAS DISPOSICIONES DE LA LEY DE LOS SERVIDORES PUBLICOS DE LA ASOCIACION. ANTES DE EMITIR ESTOS PLANOS HE VERIFICADO QUE LAS DIMENSIONES Y LOS MATERIALES DE LOS ELEMENTOS DE LA OBRA SE ADECUAN A LA ESPECIFICACION DE LOS MATERIALES QUE SE HA PRODUCCION EN EL PAIS. ESTOS PLANOS SON UN PRODUCTO DE MI OFICINA DE ARQUITECTURA Y NO SON UN PRODUCTO DE NINGUN OTRO PROFESIONAL. YO, HERNÁN R. HERNÁNDEZ, ARQUITECTO LICENCIADO, NUMERO DE LICENCIATURA 1000, CERTIFICO QUE SOY EL PROFESIONAL QUE DISEÑO ESTOS PLANOS Y QUE HE REVISADO LOS PLANOS Y ESPECIFICACIONES DE ACUERDO CON LAS REGLAS DE LA ASOCIACION PUERTORRUECA DE ARQUITECTOS Y CON LAS DISPOSICIONES DE LA LEY DE LOS SERVIDORES PUBLICOS DE LA ASOCIACION. ANTES DE EMITIR ESTOS PLANOS HE VERIFICADO QUE LAS DIMENSIONES Y LOS MATERIALES DE LOS ELEMENTOS DE LA OBRA SE ADECUAN A LA ESPECIFICACION DE LOS MATERIALES QUE SE HA PRODUCCION EN EL PAIS. ESTOS PLANOS SON UN PRODUCTO DE MI OFICINA DE ARQUITECTURA Y NO SON UN PRODUCTO DE NINGUN OTRO PROFESIONAL.




ELECTRICAL & TELECOMM CONNECTION & SUPPORT
SCALE: 1/2"=1'-0"
DETAIL I
ID: E075

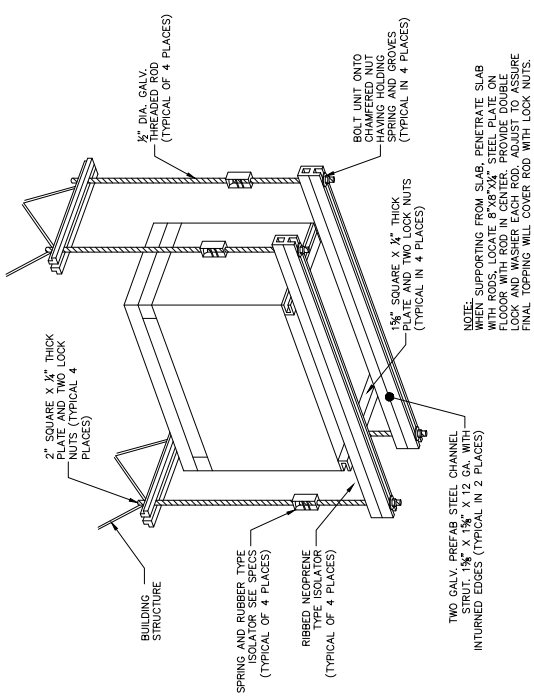


TYPICAL DETAIL: TRANSFORMER SUPPORT
SCALE: 3/4"=1'-0"
DETAIL K
ID: E060

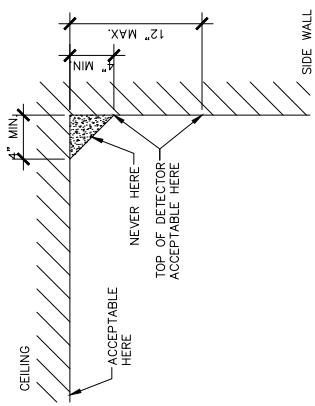


TYPICAL DETAIL: FIRE ALARM LOCATION
SCALE: 1 1/2"=1'-0"
DETAIL J
ID: F001

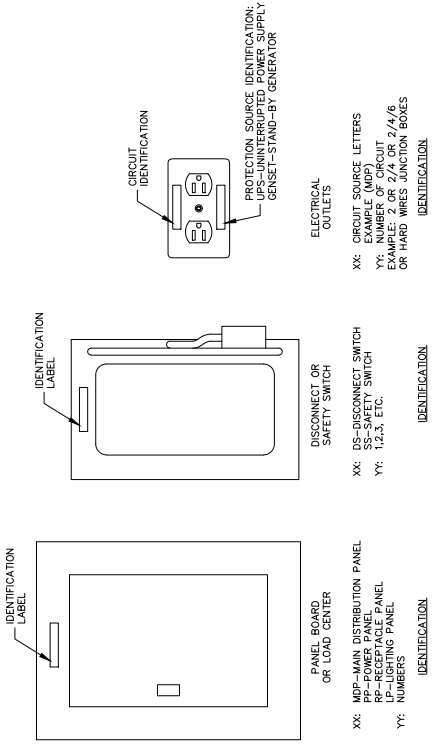


ELECTRICAL RECEPTACLE CIRCUIT IDENTIFICATION
SCALE: 3"=1'-0"
DETAIL E
ID: E074

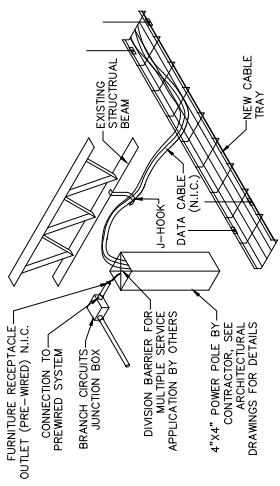


FURNITURE MULTI-SERVICE TRANSITION
SCALE: 1 1/2"=1'-0"
DETAIL F
ID: E075

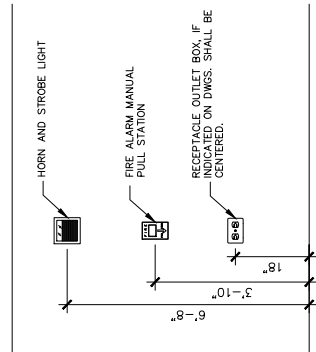


FIRE STATION & HORN INSTALLATION DETAIL
SCALE: 3/4"=1'-0"
DETAIL G
ID: F005

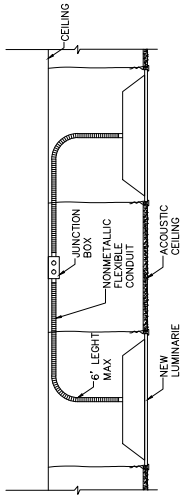


FLUORESCENT LIGHT FIXTURE TYPICAL CONNECTION
SCALE: 3/4"=1'-0"
DETAIL H
ID: E035

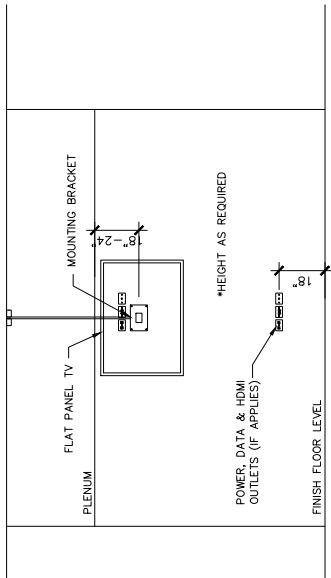


TYPICAL POWER & VIDEO OUTLET
SCALE: 1/4"=1'-0"
DETAIL A
ID: E018

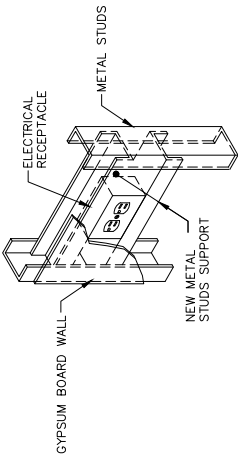

TYPICAL ELECTRICAL RECEPTACLES SUPPORT
SCALE: 1 1/2"=1'-0"
DETAIL B
ID: E073

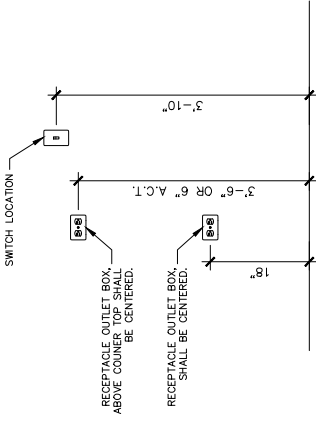

ELECTRICAL RECEPTACLES INSTALLATION DETAIL
SCALE: 3/4"=1'-0"
DETAIL C
ID: F005

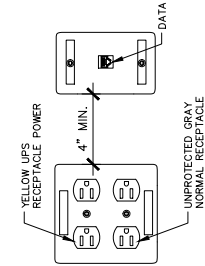

CLOSET OFFICE OUTLET LAYOUT
SCALE: 3"=1'-0"
DETAIL D
ID: E074

REV	DESCRIPTION	DATE

DESIGN: CAPTAIN
CHECKED BY:
DATE:

PROJECT NO. E0-02
SHEET NO. E0-02

SCALE: 1/8"=1'-0"

DATE:


PROJECT NO. E0-02

SHEET NO. E0-02

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DRAWING TITLE
ELECTRICAL DETAILS

SCALE: 1/8"=1'-0"
PROJECT NO. E0-02
SHEET NO. E0-02
DATE:

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EXISTING ELECTRICAL CONDITIONS TO REMAIN
CONTRACTOR SHALL VERIFY EXISTING ELECTRICAL
INFRASTRUCTURE CONDITIONS BEFORE INSTALLATION.

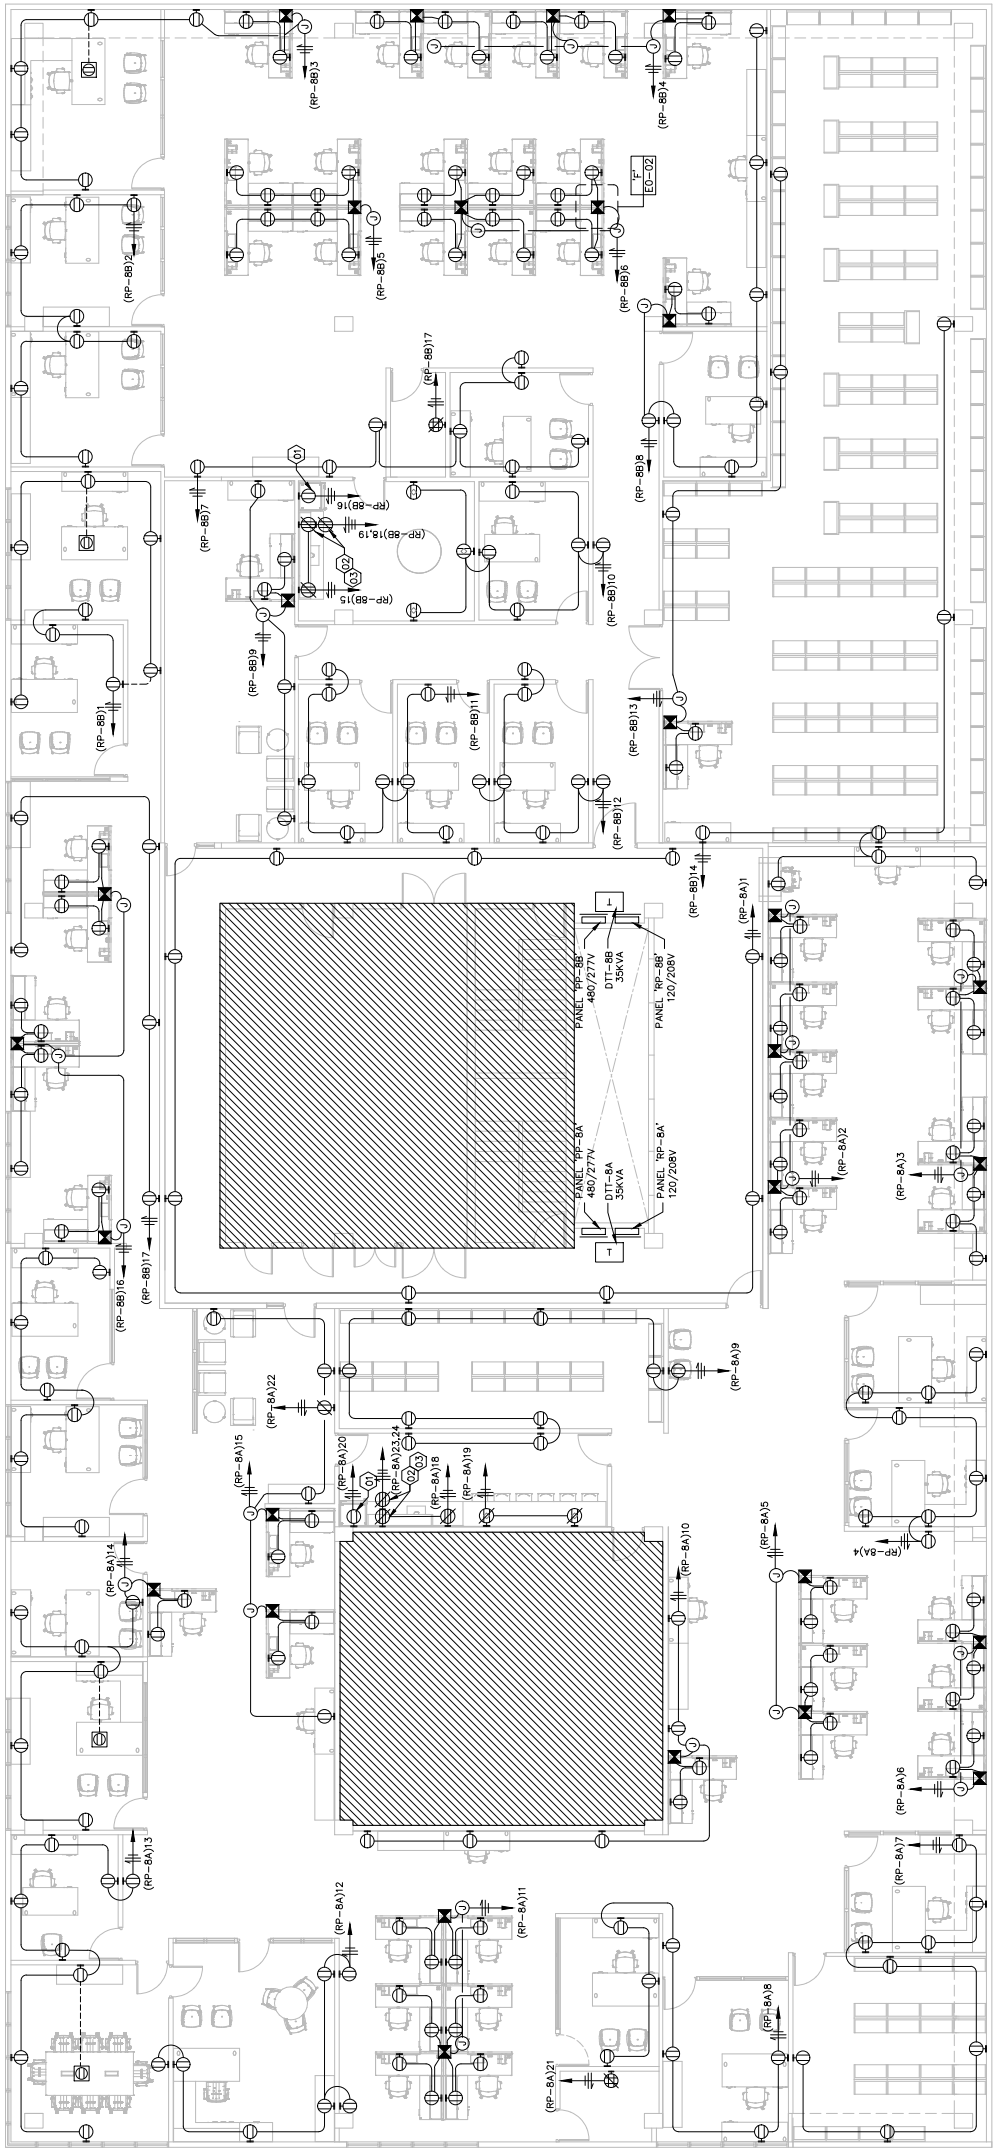ELECTRICAL FLOOR PLAN
SCALE 1/8"=1'-0"

KITCHEN EQUIPMENT ELECTRICAL SCHEDULE			
ID	DESCRIPTION	RECEPTACLE HEIGHT	EXPOSED OR CONCEALED
01	REFRIGERATOR	18"	CONCEALED
02	MICROWAVE	58"	CONCEALED
03	MICROWAVE	74"	CONCEALED

SCHEMATIC COPY
DRAWING TITLE
8TH FLOOR ELECTRICAL
FLOOR PLAN

REVISIONS

No.	DESCRIPTION	DATE

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DESIGN: R. CHARGE
JOB: CAPTAIN
CHECKED BY:
DRAWN BY:



BREAKER	CURRENT CARRYING CONDUCTOR SIZE		GROUND CONDUCTION	CONDUITS SIZE*	
	#12	#10		1 POLE	3 POLES
15A	#12	#10	#12	3/4"	3/4"
20A	#12	#10	#12	3/4"	3/4"
25A	#10	#10	#10	3/4"	3/4"
30A	#10	#10	#10	3/4"	3/4"
35A	#8	#10	#10	3/4"	3/4"
40A	#8	#10	#10	3/4"	3/4"
45A	#6	#10	#10	1"	1"
50A	#6	#10	#10	1"	1"
60A	#4	#10	#10	1 1/2"	1 1/2"
70A	#4	#8	#8	1"	1 1/2"
80A	#3	#8	#8	1"	1 1/2"
90A	#2	#8	#8	1 1/2"	1 1/2"
100A	#2	#6	#6	1 1/2"	1 1/2"
125A	#1	#6	#6	1 1/2"	1 1/2"
150A	#1/0	#6	#6	1 1/2"	2"
175A	#2/0	#6	#6	1 1/2"	2"
200A	#3/0	#3	#3	1 1/2"	2"

CONDUITS & CONDUCTOR SCHEDULE

SCALE: N.T.S.

DESIGNATION	BRAND:	SQUARE D	TYPE:	CAPACITY (A):	VOLTAGE (V)	MAIN	EXISTING	277/480V	SYSTEM:	NUM. POLES	CIRCUIT AMPS.	LOAD
ELECTRICAL ROOM	NEMA 1	100	4W	7/9/11	3	30						EMERGENCY LIGHTS DRY TYPE DIT-8A* 35KVA
DESIGNATION	BRAND:	SQUARE D <td>TYPE: <td>CAPACITY (A): <td>VOLTAGE (V) <td>MAIN <td>EXISTING <td>120/208V <td>SYSTEM: <td>NUM. POLES <td>CIRCUIT AMPS. <td>LOAD</td> </td></td></td></td></td></td></td></td></td>	TYPE: <td>CAPACITY (A): <td>VOLTAGE (V) <td>MAIN <td>EXISTING <td>120/208V <td>SYSTEM: <td>NUM. POLES <td>CIRCUIT AMPS. <td>LOAD</td> </td></td></td></td></td></td></td></td>	CAPACITY (A): <td>VOLTAGE (V) <td>MAIN <td>EXISTING <td>120/208V <td>SYSTEM: <td>NUM. POLES <td>CIRCUIT AMPS. <td>LOAD</td> </td></td></td></td></td></td></td>	VOLTAGE (V) <td>MAIN <td>EXISTING <td>120/208V <td>SYSTEM: <td>NUM. POLES <td>CIRCUIT AMPS. <td>LOAD</td> </td></td></td></td></td></td>	MAIN <td>EXISTING <td>120/208V <td>SYSTEM: <td>NUM. POLES <td>CIRCUIT AMPS. <td>LOAD</td> </td></td></td></td></td>	EXISTING <td>120/208V <td>SYSTEM: <td>NUM. POLES <td>CIRCUIT AMPS. <td>LOAD</td> </td></td></td></td>	120/208V <td>SYSTEM: <td>NUM. POLES <td>CIRCUIT AMPS. <td>LOAD</td> </td></td></td>	SYSTEM: <td>NUM. POLES <td>CIRCUIT AMPS. <td>LOAD</td> </td></td>	NUM. POLES <td>CIRCUIT AMPS. <td>LOAD</td> </td>	CIRCUIT AMPS. <td>LOAD</td>	LOAD
ELECTRICAL ROOM	NEMA 1	100	4W	20	1	20						RECEPTACLES KITCHEN COUNTER RECEPTACLES REFRIGERATOR
DESIGNATION	BRAND:	SQUARE D <td>TYPE: <td>CAPACITY (A): <td>VOLTAGE (V) <td>MAIN <td>EXISTING <td>277/480V <td>SYSTEM: <td>NUM. POLES <td>CIRCUIT AMPS. <td>LOAD</td> </td></td></td></td></td></td></td></td></td>	TYPE: <td>CAPACITY (A): <td>VOLTAGE (V) <td>MAIN <td>EXISTING <td>277/480V <td>SYSTEM: <td>NUM. POLES <td>CIRCUIT AMPS. <td>LOAD</td> </td></td></td></td></td></td></td></td>	CAPACITY (A): <td>VOLTAGE (V) <td>MAIN <td>EXISTING <td>277/480V <td>SYSTEM: <td>NUM. POLES <td>CIRCUIT AMPS. <td>LOAD</td> </td></td></td></td></td></td></td>	VOLTAGE (V) <td>MAIN <td>EXISTING <td>277/480V <td>SYSTEM: <td>NUM. POLES <td>CIRCUIT AMPS. <td>LOAD</td> </td></td></td></td></td></td>	MAIN <td>EXISTING <td>277/480V <td>SYSTEM: <td>NUM. POLES <td>CIRCUIT AMPS. <td>LOAD</td> </td></td></td></td></td>	EXISTING <td>277/480V <td>SYSTEM: <td>NUM. POLES <td>CIRCUIT AMPS. <td>LOAD</td> </td></td></td></td>	277/480V <td>SYSTEM: <td>NUM. POLES <td>CIRCUIT AMPS. <td>LOAD</td> </td></td></td>	SYSTEM: <td>NUM. POLES <td>CIRCUIT AMPS. <td>LOAD</td> </td></td>	NUM. POLES <td>CIRCUIT AMPS. <td>LOAD</td> </td>	CIRCUIT AMPS. <td>LOAD</td>	LOAD
ELECTRICAL ROOM	NEMA 1	100	4W	7/9/11	3	30						EMERGENCY LIGHTS DRY TYPE DIT-8B* 35KVA
DESIGNATION	BRAND:	SQUARE D <td>TYPE: <td>CAPACITY (A): <td>VOLTAGE (V) <td>MAIN <td>EXISTING <td>120/208V <td>SYSTEM: <td>NUM. POLES <td>CIRCUIT AMPS. <td>LOAD</td> </td></td></td></td></td></td></td></td></td>	TYPE: <td>CAPACITY (A): <td>VOLTAGE (V) <td>MAIN <td>EXISTING <td>120/208V <td>SYSTEM: <td>NUM. POLES <td>CIRCUIT AMPS. <td>LOAD</td> </td></td></td></td></td></td></td></td>	CAPACITY (A): <td>VOLTAGE (V) <td>MAIN <td>EXISTING <td>120/208V <td>SYSTEM: <td>NUM. POLES <td>CIRCUIT AMPS. <td>LOAD</td> </td></td></td></td></td></td></td>	VOLTAGE (V) <td>MAIN <td>EXISTING <td>120/208V <td>SYSTEM: <td>NUM. POLES <td>CIRCUIT AMPS. <td>LOAD</td> </td></td></td></td></td></td>	MAIN <td>EXISTING <td>120/208V <td>SYSTEM: <td>NUM. POLES <td>CIRCUIT AMPS. <td>LOAD</td> </td></td></td></td></td>	EXISTING <td>120/208V <td>SYSTEM: <td>NUM. POLES <td>CIRCUIT AMPS. <td>LOAD</td> </td></td></td></td>	120/208V <td>SYSTEM: <td>NUM. POLES <td>CIRCUIT AMPS. <td>LOAD</td> </td></td></td>	SYSTEM: <td>NUM. POLES <td>CIRCUIT AMPS. <td>LOAD</td> </td></td>	NUM. POLES <td>CIRCUIT AMPS. <td>LOAD</td> </td>	CIRCUIT AMPS. <td>LOAD</td>	LOAD
ELECTRICAL ROOM	NEMA 1	100	4W	16	1	20						REFRIGERATOR TELECOMM RACK #2 MICROWAVE RECEPTACLE

ELECTRICAL PANEL SCHEDULE

SCALE: N.T.S.

ID	DESCRIPTION	MANUFACTURER	MODEL	VOLTS	BALLAST TYPE	LAMPS OR TUBES		TOTAL WATTS
						NUM.	WATTS	
L1	2'x2' LED FIXTURE	LITHONIA LIGHTING	3460LM 60 CSR 40K MIN/10 2T 277V	277	DR	-	-	-
ES	EXIT SIGN	LITHONIA LIGHTING	EC86 LED M6	277	DR	1	3	LED 3

FIXTURE NOTES:
-EB DENOTES 'ELECTRONIC BALLAST'.
-DB DENOTES 'DIMMABLE BALLAST'.
-IN DENOTES 'INCANDESCENT LAMP'.

*FOR MORE DETAILS REFER TO ARCHITECTURAL DRAWINGS ON SHEET A-2.2

LIGHTING SCHEDULE

SCALE: N.T.S.

REVISIONS		DATE
No.	DESCRIPTION	

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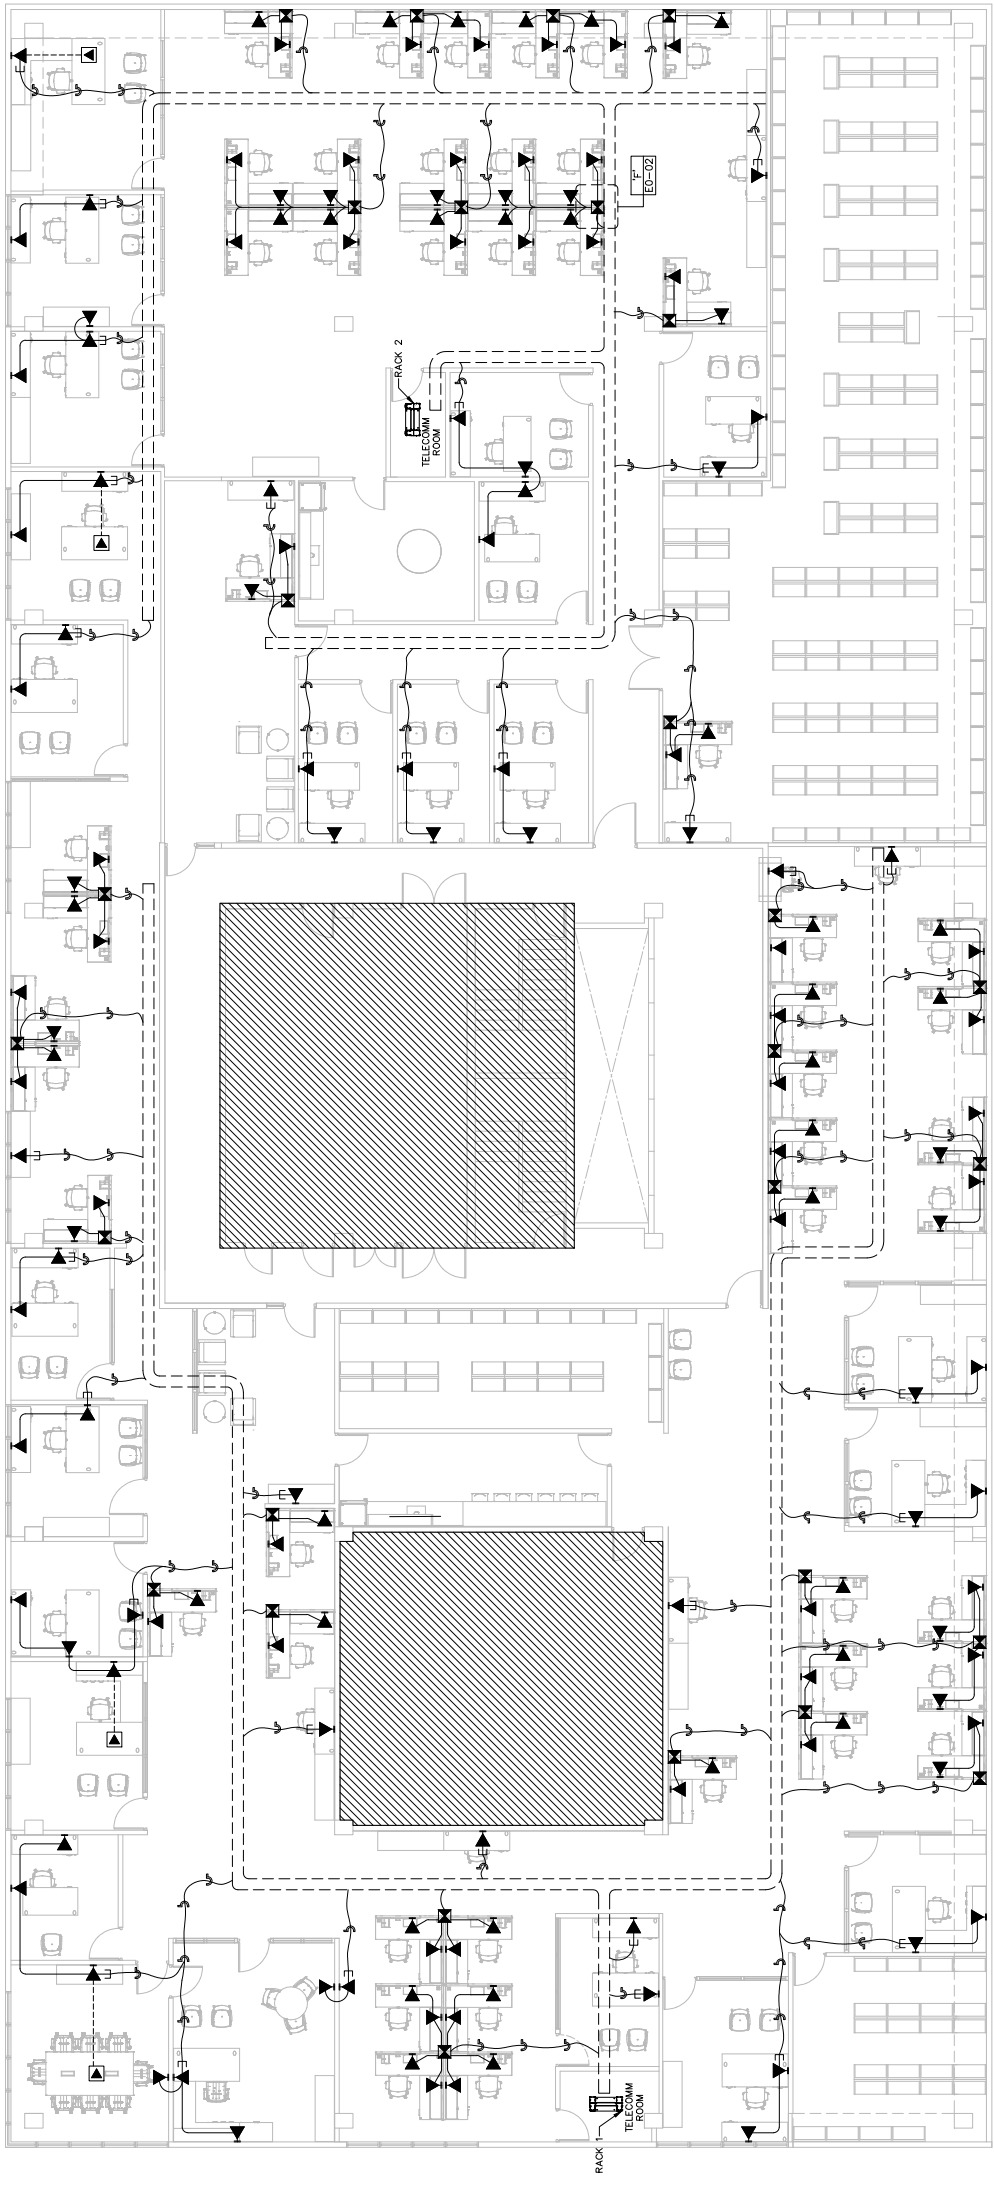
PREPARED BY: JORGE RAMIREZ
DESIGN: JOSE CAPRIN
CHECKED BY:
DRAWN BY:

SCHEMATIC COPY

DRAWING TITLE

ELECTRICAL SCHEDULES

SCALE: 1/8"=1'-0"	DRAWING No. E2-01
PROJECT No.	SHEET No.
DATE	



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CONTRACTOR SHALL VERIFY EXISTING ELECTRICAL
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TELECOMM FLOOR PLAN
SCALE 1/8"=1'-0"

REVISIONS	
No.	DESCRIPTION

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DESIGN IN CHARGE
DESIGN OFFICE
JOB NUMBER
CHECKED BY
DRAWN BY

PRELIMINARY COPY
DRAWING TITLE
8TH FLOOR TELECOMM
FLOOR PLAN

SCALE	1/8"=1'-0"
PROJECT No.	T1-01
DATE	
SHEET No.	

